










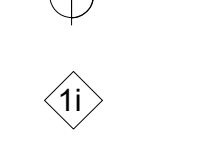
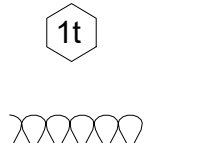
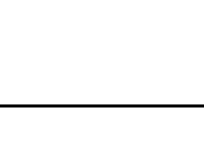
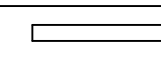
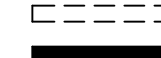

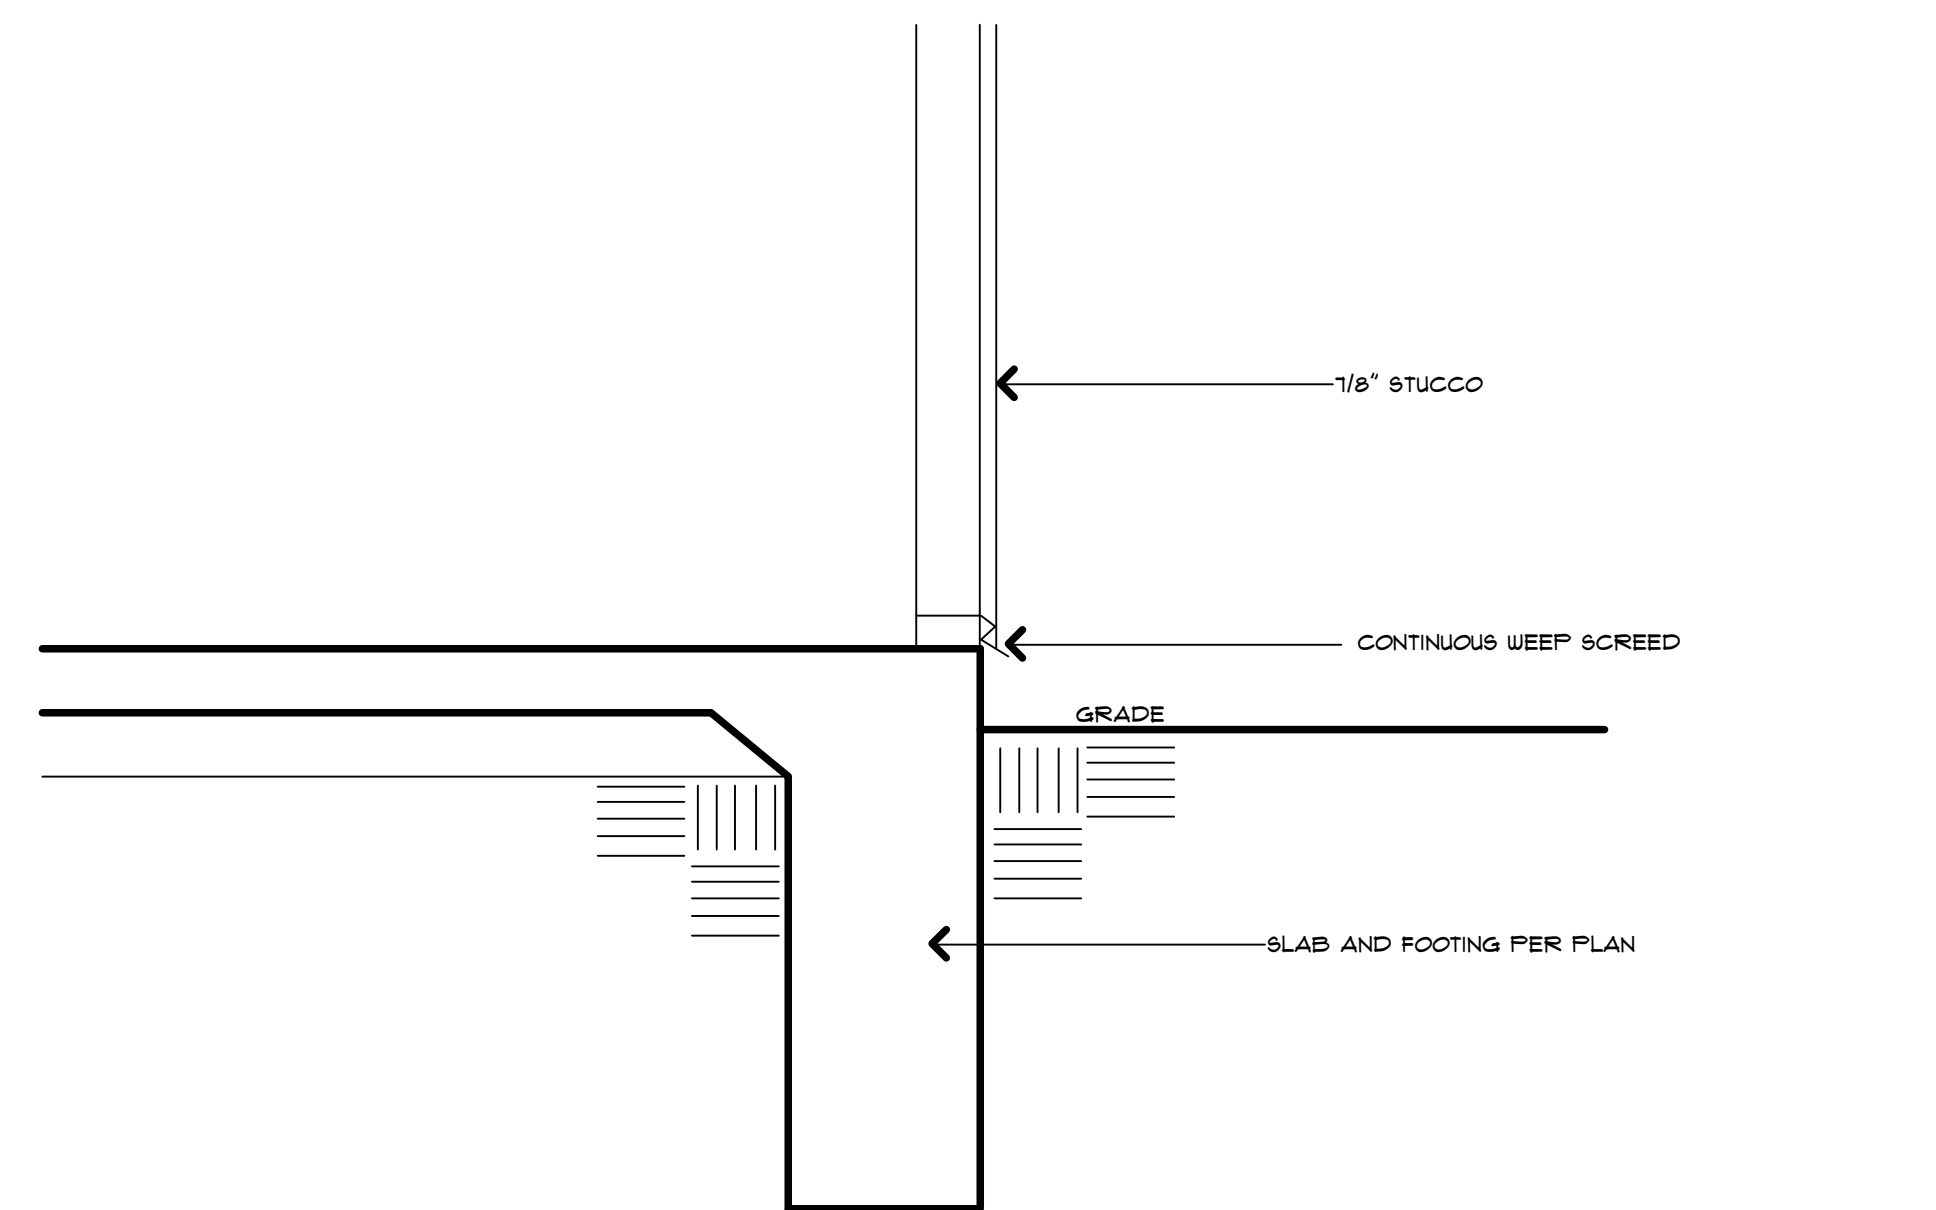


**SYMBOLS**

-  **PLAN DETAIL REFERENCE -**  
1 = Detail Number  
A101 = Sheet Number
-  **DOOR TAG (See Door Schedule)**
-  **INTERIOR ELEVATION REFERENCE**  
A101 = Sheet Number  
1 = Detail Number  
Ref = Detail Name
-  **EXTERIOR ELEVATION REFERENCE**  
A101 = Sheet Number  
1 = Detail Number  
Ref = Detail Name
-  **BUILDING LEVEL REFERENCE**
-  **REVISION TAG**
-  **ROOM REFERENCE - (See Room Schedule)**  
101 = Room Number
-  **SECTION CALLOUT HEAD -**  
1 = Detail Number  
A101 = Sheet Number
-  **DETAIL REFERENCE TAIL -**  
1 = Detail Number  
A101 = Sheet Number
-  **SECTION TAIL -**  
Shows Direction of Section View
-  **ELEVATION TAG**
-  **WALL TAG (See Wall Schedule)**
-  **WINDOW TAG (See Window Schedule)**
-  **BUILDING INSULATION - REFER TITLE 24**

**WALL LEGEND**

EXISTING TO REMAIN	
EXISTING TO BE REMOVED	
NEW WALL TO BE BUILT	

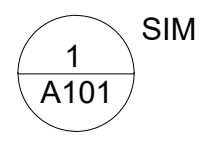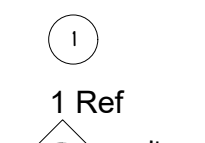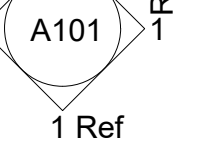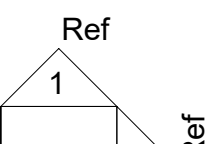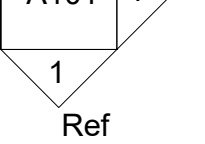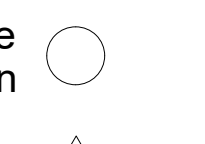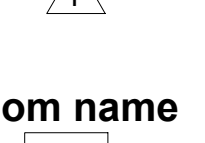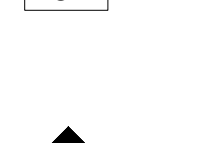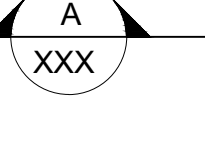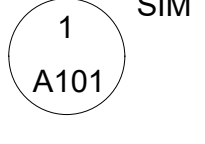

PROVIDE A WEEP SCREED FOR STUCCO AT THE FOUNDATION PLATE LINE A MINIMUM OF 4 INCHES ABOVE EARTH OR 2 INCHES ABOVE PAVED AREAS (R103.12.1).

**WEEP SCREED**

SCALE: 1" = 1'-0"

NOTE: THE DISCHARGE OF POLLUTANTS TO ANY STORM DRAINAGE SYSTEM IS PROHIBITED PER THE VENTURA COUNTY WIDE MUNICIPAL STORM WATER NPDES PERMIT NUMBER CAS0004402. NO SOLID WASTE, PETROLEUM BY-PRODUCTS, SOL PARTICULATE, CONSTRUCTION WASTE MATERIALS, OR WASTEWATER OR WASTEWATER GENERATED ON CONSTRUCTION SITES OR BY THE CONSTRUCTION ACTIVITIES SHALL BE PLACED, CONVEYED OR DISCHARGED INTO THE STREET, GUTTER OR STORM DRAIN SYSTEM.

NOTE: INSTALL SMOKE DETECTORS IN ALL SLEEPING ROOMS AND HALLWAYS AS NOTED PER PLAN. SMOKE DETECTORS SHALL NOT BE LOCATED MORE THAN 3 FEET HORIZONTALLY FROM THE DOOR OR OPENING. SMOKE DETECTORS SHALL BE HARDWIRED AND INTERCONNECTED WHERE AS WHEN ONE ALARM GOES OFF, THEY ARE ALL ACTIVATED. SMOKE ALARMS SHALL HAVE A 10 YEAR BATTERY BACK-UP.

NOTE: PROVIDE ONE CARBON MONOXIDE DETECTOR IN HALLWAY PER PLAN. CARBON MONOXIDE DETECTOR SHALL HAVE A 10 YEAR BATTERY BACK-UP.

NOTE: EXTERIOR LATH PROVIDE TWO LAYERS OF GRADE "D" PAPER OVER ALL WOOD BASE SHEATHING. LATH SHALL BE INSTALLED INDEPENDENTLY (R103.12.1) PROVIDE A WEEP SCREED FOR STUCCO AT THE FOUNDATION PLATE LINE A MINIMUM OF 4 INCHES ABOVE EARTH OR 2 INCHES ABOVE PAVED AREAS (R103.12.1).

NOTE: HOSE BIBS SHALL BE INSTALLED WITH ANTI-SIPHON VALVES.

NOTE: SHOWER COMPARTMENTS AND WALLS ABOVE BATHUBS WITH SHOWER HEADS SHALL BE FINISHED WITH A SMOOTH, NONABSORBENT SURFACE TO A HEIGHT NOT LESS THAN 6 FEET ABOVE FLOOR (R301.2).

NOTE: PROVIDE MECHANICAL VENTILATION FOR BATHROOMS AND LAUNDRY ROOMS.

NOTE: MANDATORY REQUIREMENTS FOR LIGHTING ON THE PLAN:  
ALL LIGHTING SHALL BE HIGH EFFICACY. SCREW BASED LUMINAIRES MUST CONTAIN LAMPS LISTED AS JAB-2016 CERTIFIED.  
LIBRARIES, DENS, BEDROOMS, BATHROOMS, RECREATION ROOMS, CLOSETS, HALLWAYS, LAUNDRY ROOMS OR SIMILAR ROOMS OR AREAS SHALL BE PROTECTED BY A LISTED ARC-FAULT CIRCUIT INTERRUPTER, COMBINATION-TYPE (CEC 210.12).  
TYPICAL.

NOTE: EXTERIOR LIGHTING MOUNTED ON THE BUILDING TO BE HIGH EFFICACY AND EQUIPPED WITH OCCUPANT SENSOR.  
LIBRARIES, DENS, BEDROOMS, BATHROOMS, RECREATION ROOMS, CLOSETS, HALLWAYS, LAUNDRY ROOMS OR SIMILAR ROOMS OR AREAS SHALL BE PROTECTED BY A LISTED ARC-FAULT CIRCUIT INTERRUPTER, COMBINATION-TYPE (CEC 210.12).  
TYPICAL.

NOTE: EXTERIOR LIGHTING MOUNTED ON THE BUILDING TO BE HIGH EFFICACY AND EQUIPPED WITH OCCUPANT SENSOR.  
LIBRARIES, DENS, BEDROOMS, BATHROOMS, RECREATION ROOMS, CLOSETS, HALLWAYS, LAUNDRY ROOMS OR SIMILAR ROOMS OR AREAS SHALL BE PROTECTED BY A LISTED ARC-FAULT CIRCUIT INTERRUPTER, COMBINATION-TYPE (CEC 210.12).  
TYPICAL.

NOTE: EXTERIOR LIGHTING MOUNTED ON THE BUILDING TO BE HIGH EFFICACY AND EQUIPPED WITH OCCUPANT SENSOR.  
LIBRARIES, DENS, BEDROOMS, BATHROOMS, RECREATION ROOMS, CLOSETS, HALLWAYS, LAUNDRY ROOMS OR SIMILAR ROOMS OR AREAS SHALL BE PROTECTED BY A LISTED ARC-FAULT CIRCUIT INTERRUPTER, COMBINATION-TYPE (CEC 210.12).  
TYPICAL.

TABLE #1: SUMMARY OF COMPLIANT LUMINAIRE TYPES

HIGH EFFICACY LUMINAIRES	JAB HIGH EFFICACY LIGHTING LAMPS AND LIGHT SOURCES THAT MUST BE JAB-CERTIFIED.	RECESSED DOWNLIGHTS LUMINAIRES IN CEILING
ON-BASED LINEAR FLUORESCENT. PIN-BASED COMPACT FLUORESCENT. FLUORESCENT METAL HALIDE. HIGH PRESSURE SODIUM. GU-24 OTHER THAN LED'S. INSEPARABLE SSL LUMINAIRES WITH COLORED LIGHT SOURCES FOR DECORATIVE LIGHTING PURPOSE.	LED LUMINAIRE WITH INTEGRAL SOURCES. SCREW-BASED LED LAMPS (A-LAMPS, PAR LAMPS, ETC.). PIN-BASED LED LAMPS (MR-16, AR-11, ETC.). GU-24 BASED LED LIGHT SOURCE. ANY SOURCE OR LUMINAIRE NOT LISTED ELSEWHERE ON THIS TABLE.	SHALL NOT HAVE SCREW BASED SOCKETS. SHALL CONTAIN JAB-CERTIFIED LIGHT SOURCES. SHALL MEET ALL PERFORMANCE REQUIREMENTS IN 150.0 (C) 1C.


ALL 120-VOLT, SINGLE PHASE 15 AND 20 AMPERE BRANCH CIRCUITS IN KITCHEN, FAMILY ROOMS, DINING ROOMS, LIVING ROOMS, PARLORS, LIBRARIES, DENS, BEDROOMS, BATHROOMS, RECREATION ROOMS, CLOSETS, HALLWAYS, LAUNDRY ROOMS OR SIMILAR ROOMS OR AREAS SHALL BE PROTECTED BY A LISTED ARC-FAULT CIRCUIT INTERRUPTER, COMBINATION-TYPE (CEC 210.12).  
TYPICAL.

NEW PLUMBING CODE AMENDMENT EFFECTIVE 10/28/2016  
DUAL FLUSH WATER CLOSETS (1/11 & GPF) AVERAGE 1.39  
LAVATORY FAUCETS, SENSOR OPERATED, SELF CLOSING  
NOTE: EXTERIOR LIGHTING MOUNTED ON THE BUILDING TO BE HIGH EFFICACY AND CONTROLLED BY PHOTO CONTROL/MOTION SENSOR COMBINATION.

NOTE: MANDATORY REQUIREMENTS FOR LIGHTING ON THE PLAN:  
LIGHTS IN EXHAUST FANS SHALL BE HIGH EFFICACY.  
LIGHT BULBS SHALL BE JAB-2016 CERTIFIED.  
NOTE: INSULATE ALL HOT ACCESSIBLE WATER PIPING.  
INSULATE ALL PIPING WITH A NOMINAL DIAMETER OF 3/4 INCH.  
NOTE: EXTERIOR LIGHTING MOUNTED ON THE BUILDING TO BE HIGH EFFICACY AND CONTROLLED BY PHOTO CONTROL/MOTION SENSOR COMBINATION.


NOTE: EXTERIOR LIGHTING MOUNTED ON THE BUILDING TO BE HIGH EFFICACY AND CONTROLLED BY PHOTO CONTROL/MOTION SENSOR COMBINATION.  
LIBRARIES, DENS, BEDROOMS, BATHROOMS, RECREATION ROOMS, CLOSETS, HALLWAYS, LAUNDRY ROOMS OR SIMILAR ROOMS OR AREAS SHALL BE PROTECTED BY A LISTED ARC-FAULT CIRCUIT INTERRUPTER, COMBINATION-TYPE (CEC 210.12).  
TYPICAL.

NOTE: EXTERIOR LIGHTING MOUNTED ON THE BUILDING TO BE HIGH EFFICACY AND CONTROLLED BY PHOTO CONTROL/MOTION SENSOR COMBINATION.  
LIBRARIES, DENS, BEDROOMS, BATHROOMS, RECREATION ROOMS, CLOSETS, HALLWAYS, LAUNDRY ROOMS OR SIMILAR ROOMS OR AREAS SHALL BE PROTECTED BY A LISTED ARC-FAULT CIRCUIT INTERRUPTER, COMBINATION-TYPE (CEC 210.12).  
TYPICAL.

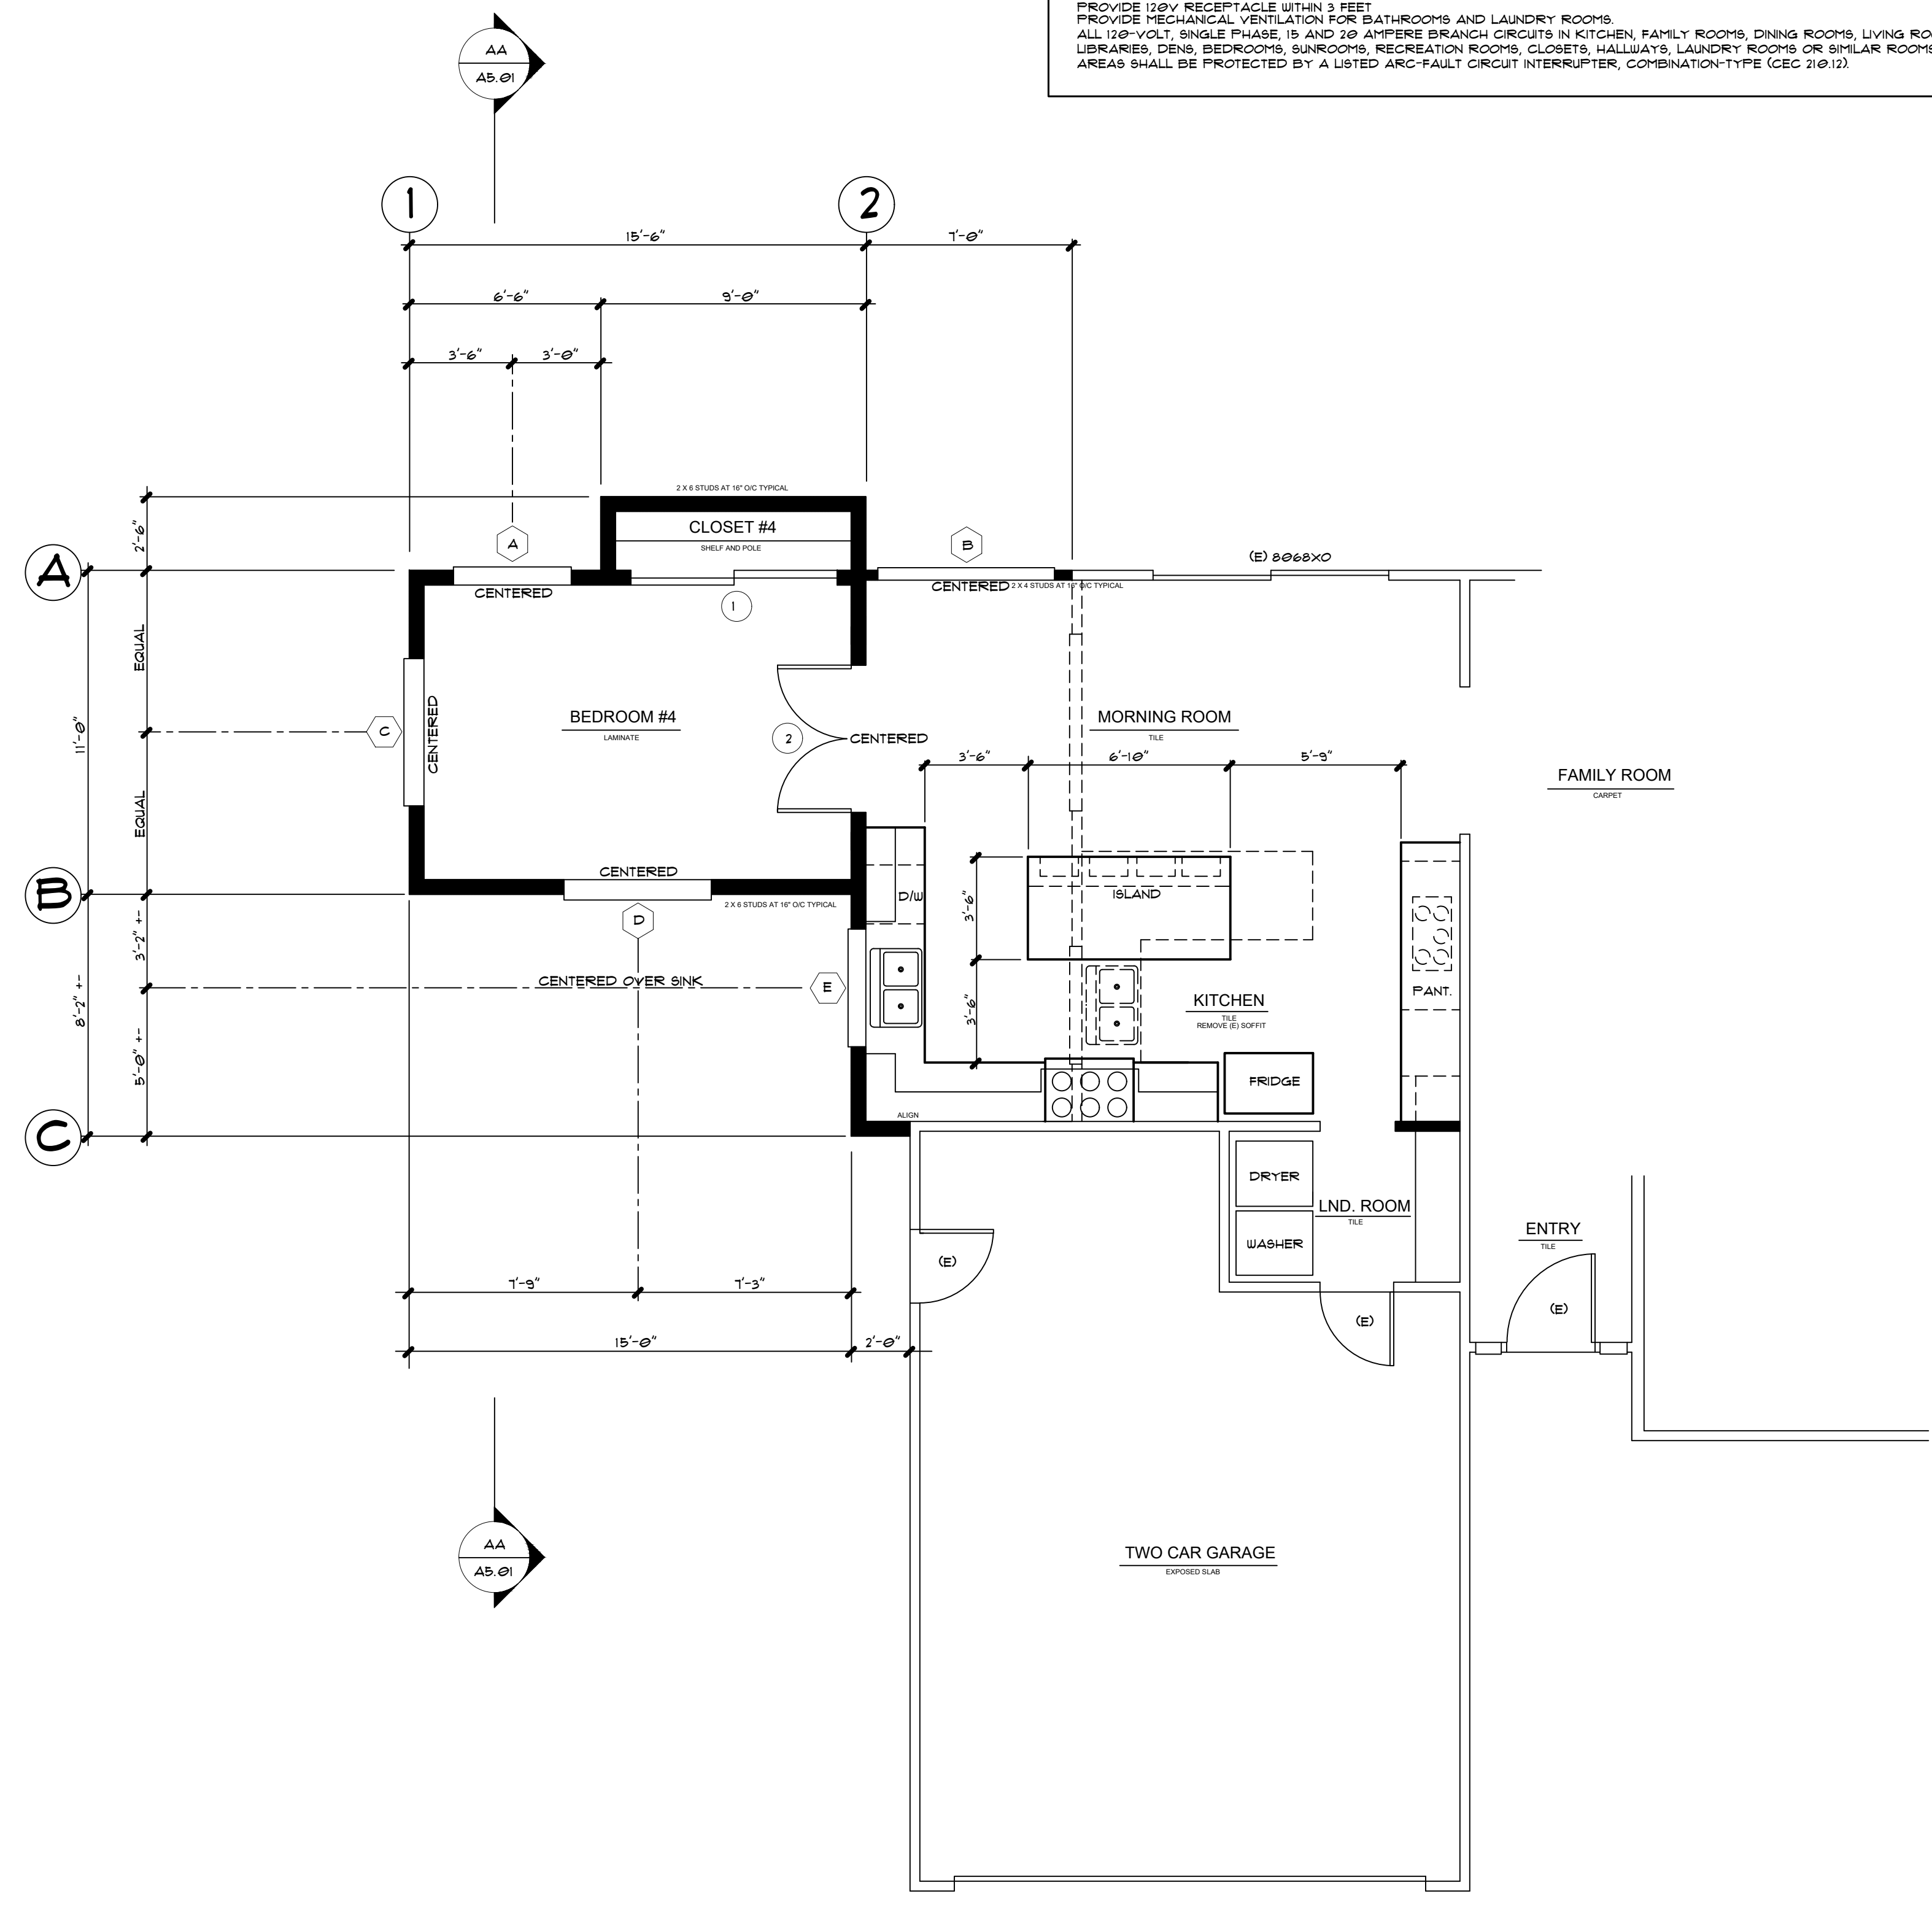

**EXISTING/DEMOLITION/  
PROPOSED FIRST FLOOR PLAN**

SCALE: 1/4" = 1'-0"

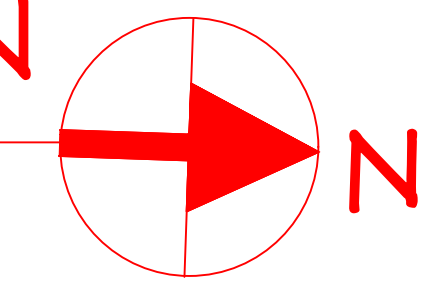


**DESIGNED BY: D.C. FOOTE, INCORPORATED (805) 444-1230 dcfoote@dcfoote.com**

REVISIONS	BY
△	DCF
△	DCF
△	DCF

ASSOCIATE MEMBER OF  
AMERICAN INSTITUTE OF ARCHITECTS

D.C.FOOTE - ASSOCIATE AIA

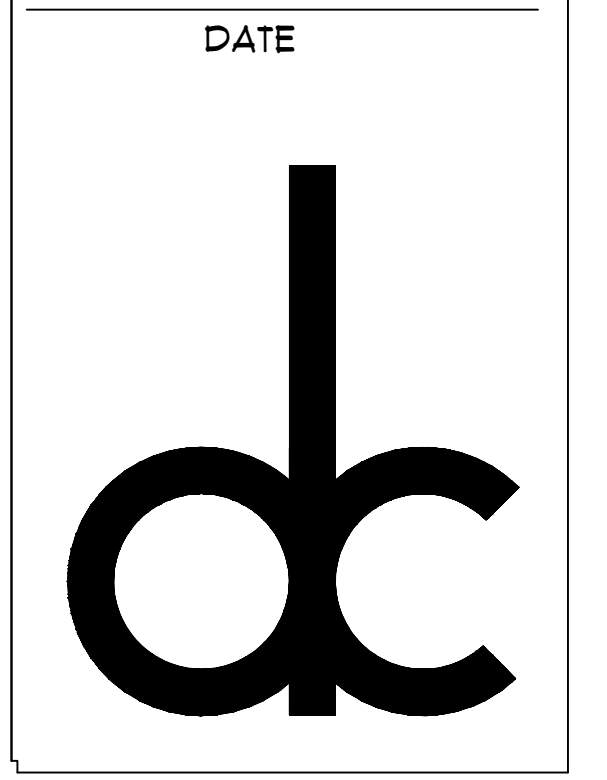

D.C. FOOTE, INCORPORATED  
501 MOBIL AVENUE, SUITE A  
CAMARILLO, CALIFORNIA 93010  
CELL: (805) 444-1230  
DCFOOTE@DCFOOTE.COM  
WWW.DCFOOTE.COM

SHEET TITLE  
**PROPOSED FIRST FLOOR PLAN**

PROJECT TITLE  
**PROPOSED ADDITION FOR:  
CAMARILLO, CALIFORNIA**

JOB NUMBER  
127121A02

DRAWN BY: D.C.FOOTE  
CHECKED: JDF  
DATE: MARCH 01, 2021  
SCALE: NOTED  
SHEET

**A3.02**